



SCALE:1"=100'

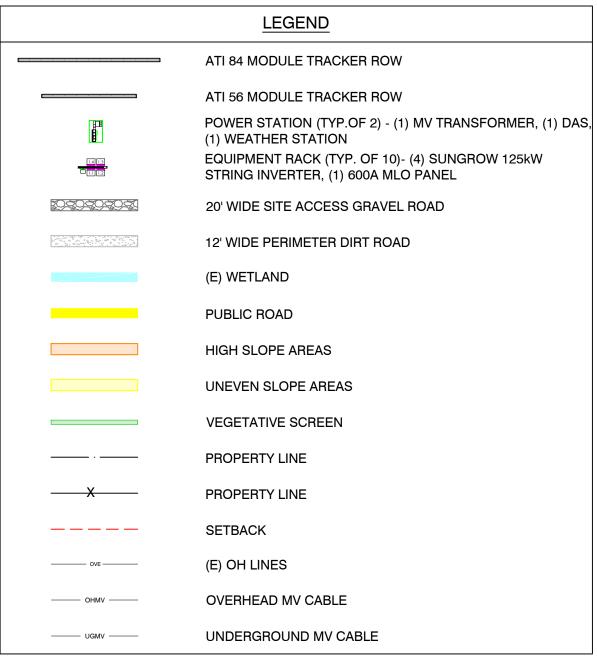


GENERAL NOTES

1. REFER TO SINGLE LINE DIAGRAM FOR DETAILS.

- 2. INSTALLATION TO COMPLY WITH NEC 2014 ARTICLE 690 AND ALL APPLICABLE LOCAL, STATE AND NATIONAL CODES OR REGULATIONS.
- B. EQUIPMENT SHALL BE LABELED PER NEC 690 AND UTILITY REGULATIONS.
- 4. 20' ACCESS ROADS SHALL BE DESIGNED TO ACCOMMODATE ALL CONSTRUCTION, OPERATIONS, MAINTENANCE, AND UTILITY TRAFFIC THROUGHOUT THE SITE.
- DIMENSIONS TO PROPERTY LINES AND EXISTING FEATURES ARE APPROXIMATE PENDING SURVEY.
- 6. THE CROSS SECTION OF THE PROPOSED 10 FT WIDE ROAD WILL MATCH THE EXISTING GRADE, WHICH SLOPES TOWARD THE PERIMETER FENCE. ROAD CROSS SECTIONS WILL BE DESIGNED TO DRAIN TOWARDS THE FENCE. FINAL CIVIL DESIGN WILL SPECIFY THE PROPOSED GRADES.
- 7. ALL DRIVE AISLES WILL COMPLY WITH BMC CHAPTER 17.74.

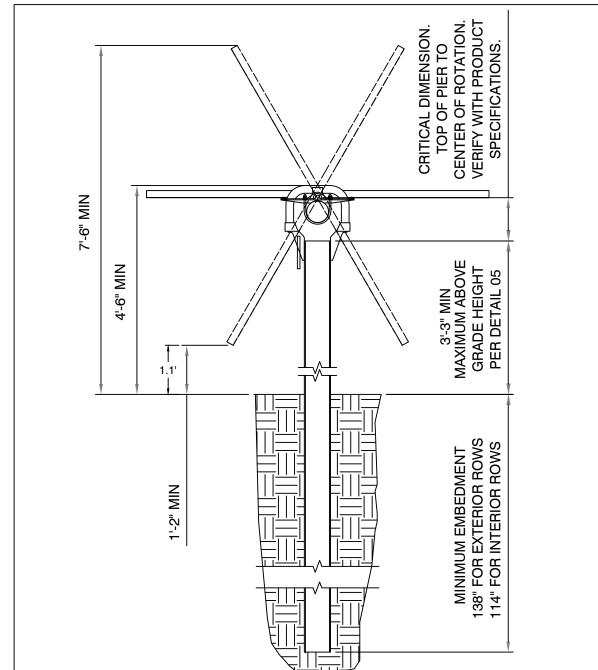

2 RACKING ELEVATION SCALE:NTS

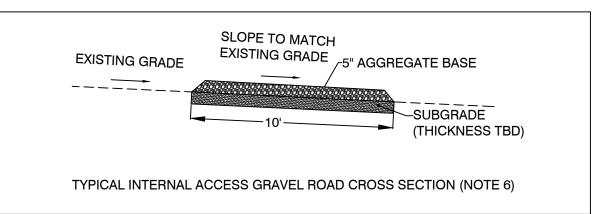


GRAVEL ROAD CROSS SECTION
SCALE:NTS



LAKE HERMAN SOLAR

LAKE HERMAN RD, BENICIA, CA 94510, USA

LAT: 38.097075° LON: -122.141678°

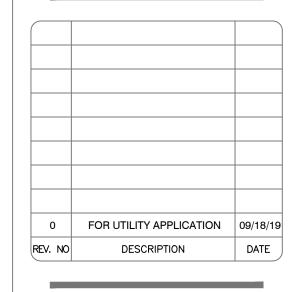

SHEET TITLE:

PRELIMINARY LAYOUT

DRAWING NO.:

PV-100

DRAWN BY:

LR


REVIEWED BY:

DATE: **09/17/19**

SCALE:

AS SHOWN


PROJECT NO.:

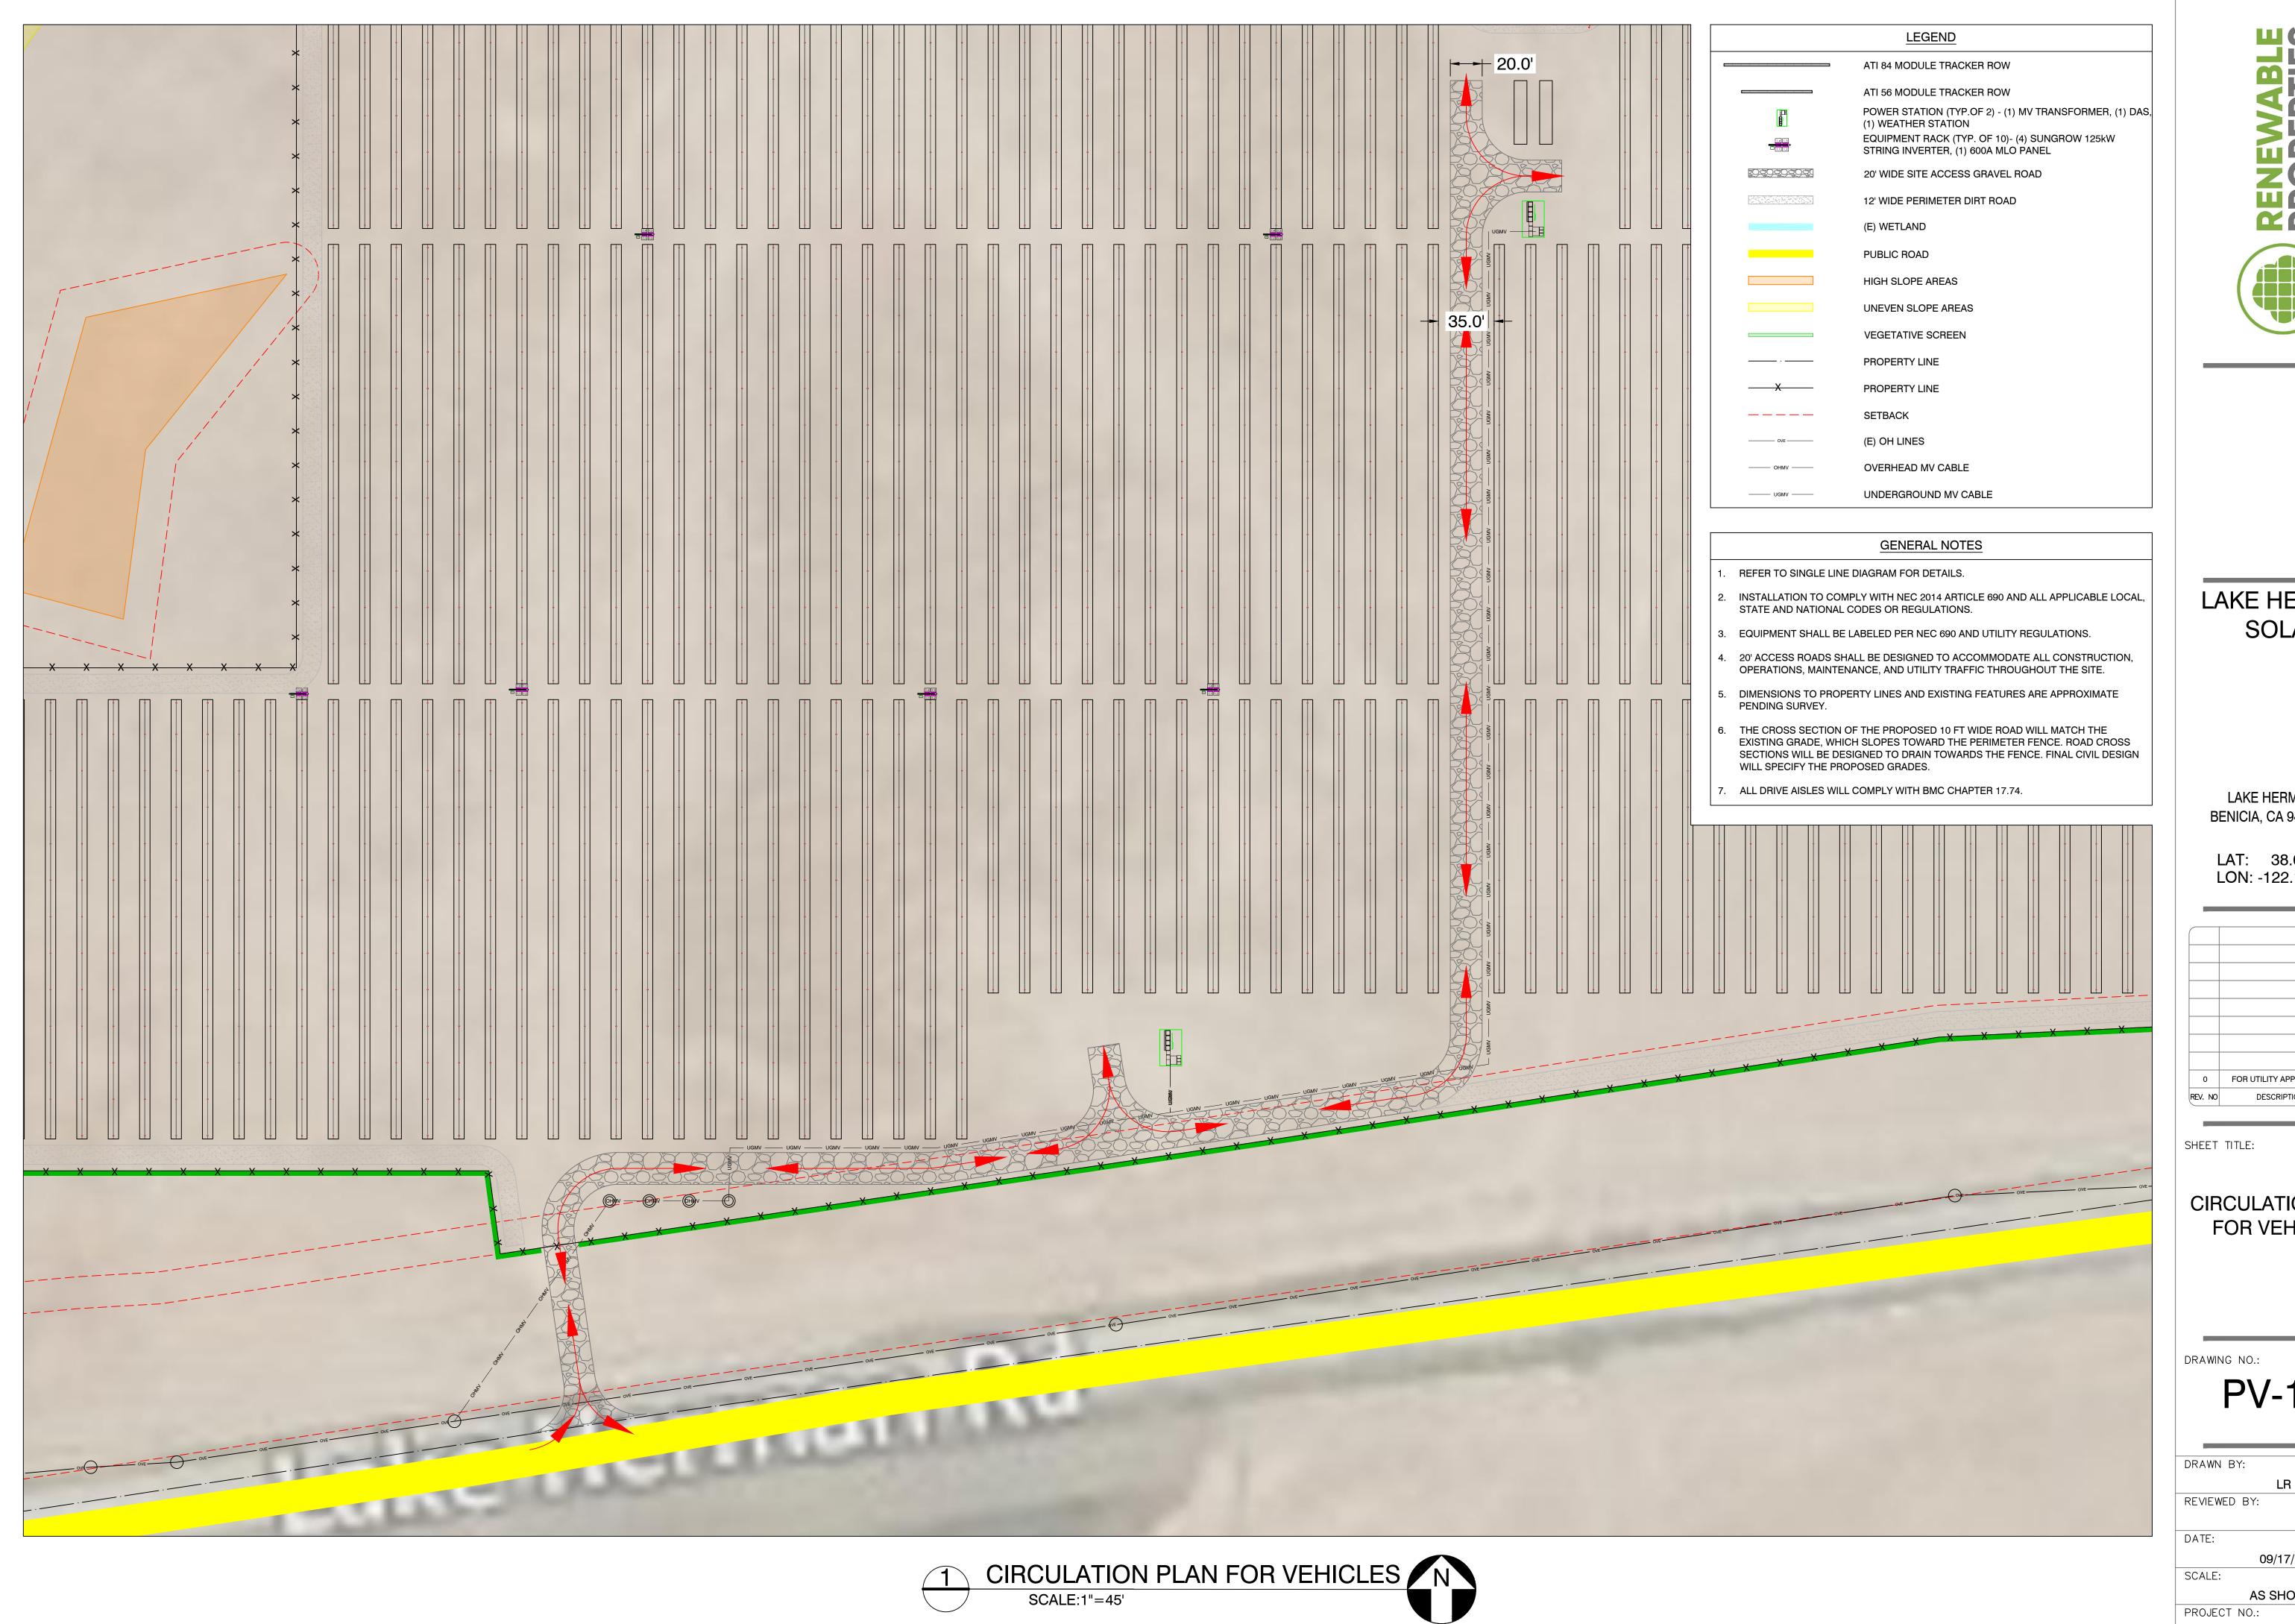

LAKE HERMAN SOLAR

LAKE HERMAN RD, BENICIA, CA 94510, USA

LAT: 38.097075° LON: -122.141678°

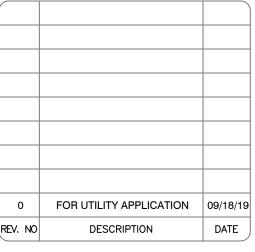


CIRCULATION PLAN FOR VEHICLES

PV-101


09/17/19

AS SHOWN

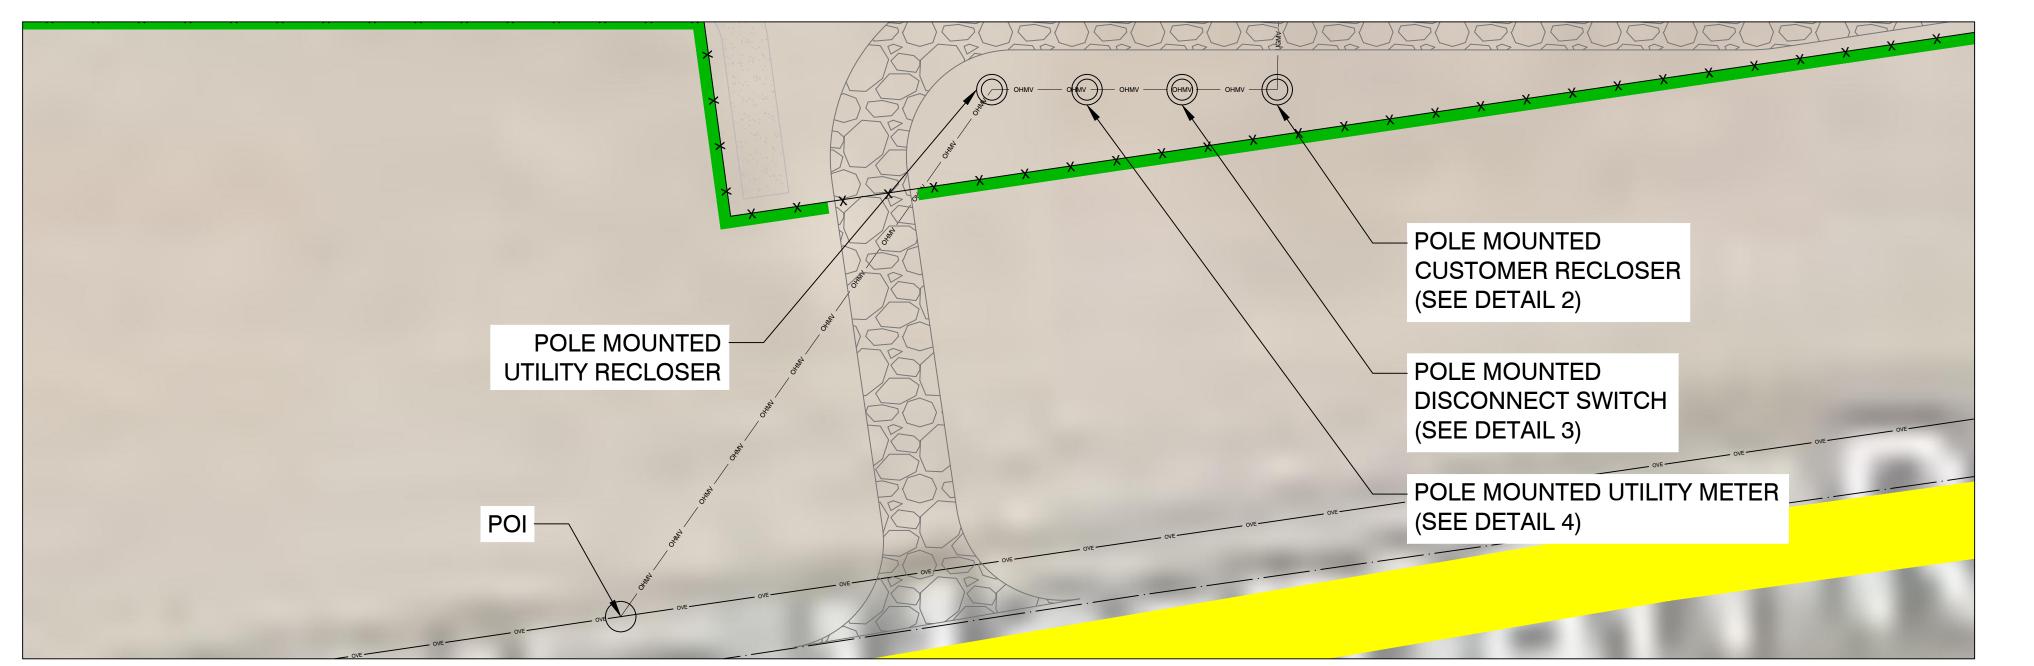





1 INTERCONNECTION DETAILS SCALE: NTS

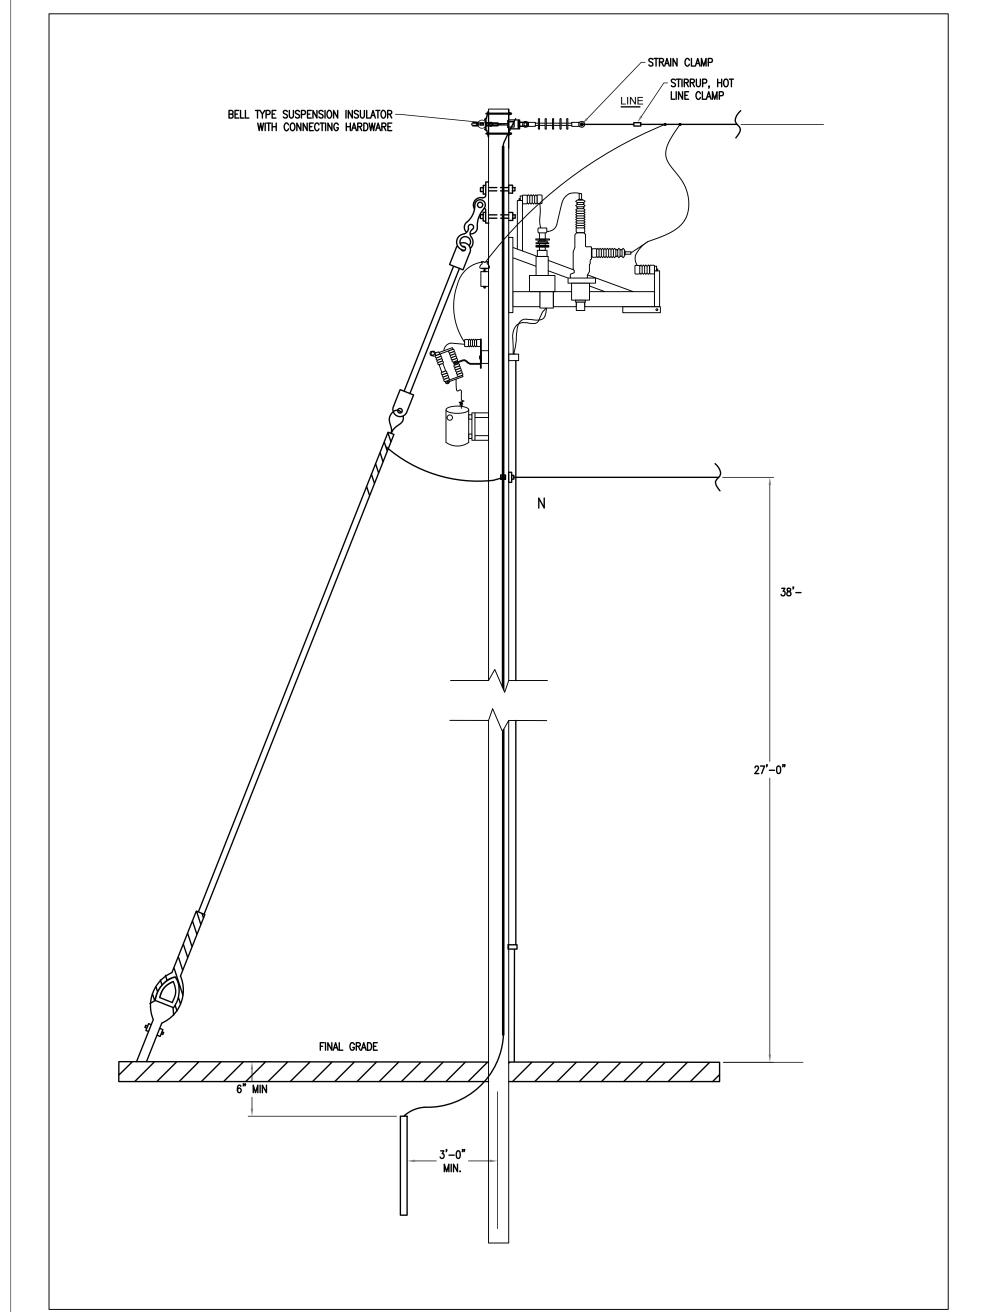



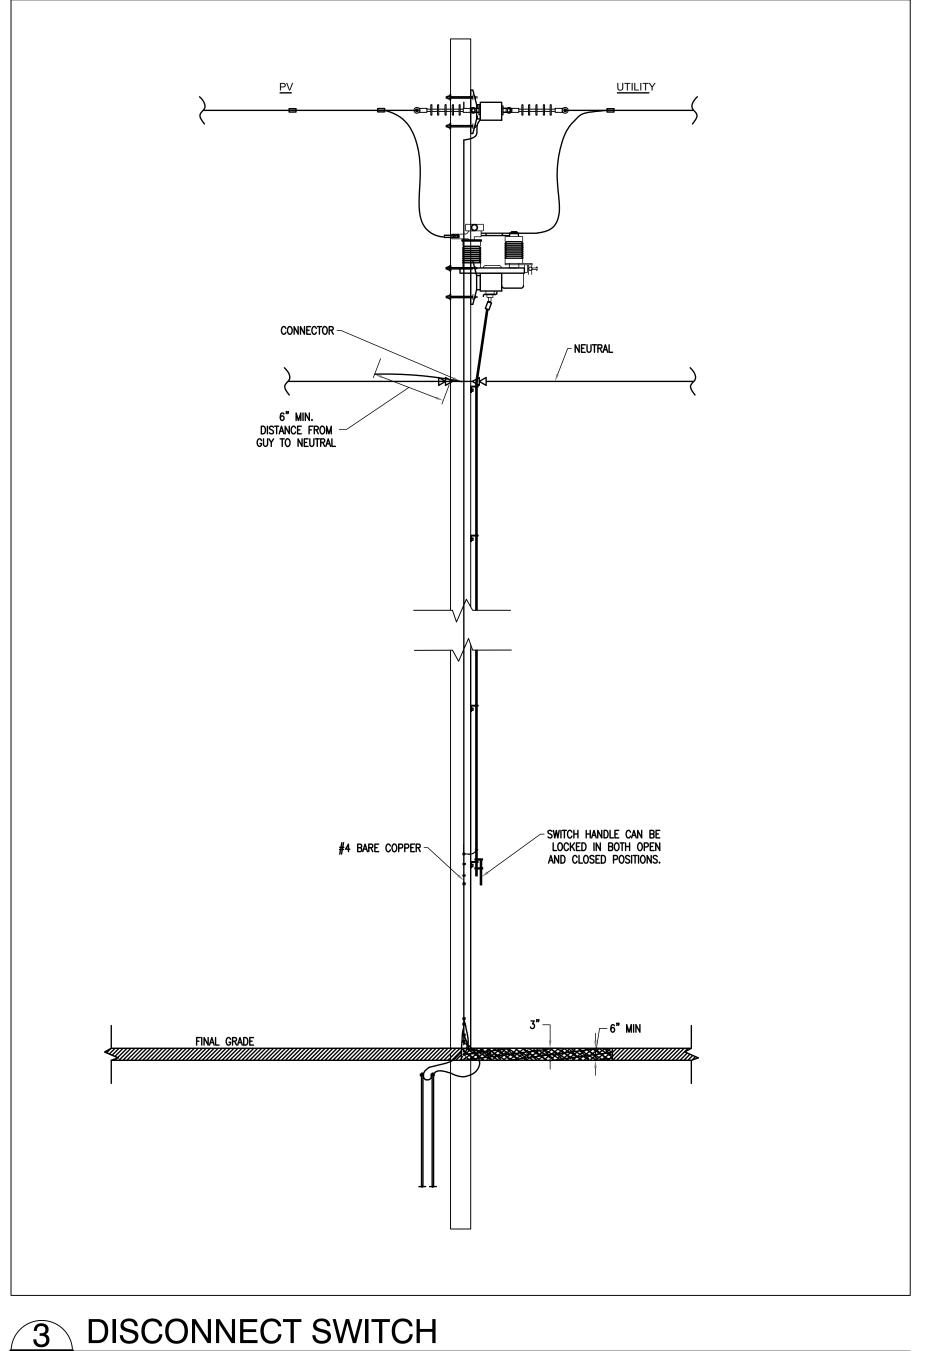


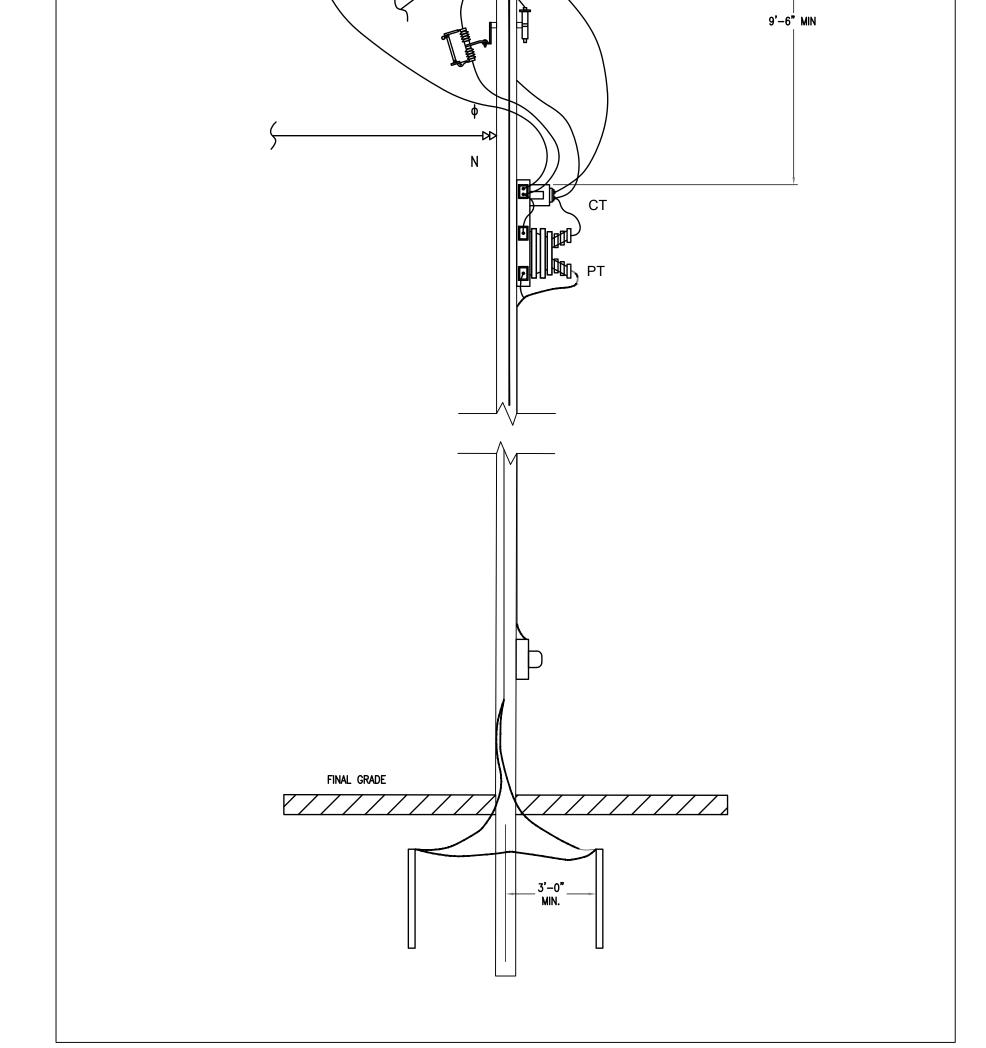

LAKE HERMAN SOLAR

LAKE HERMAN RD, BENICIA, CA 94510, USA

LAT: 38.097075° LON: -122.141678°

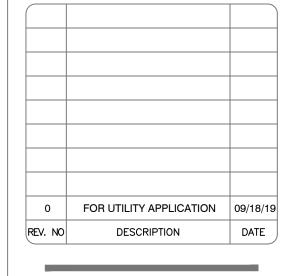

SHEET TITLE:

INTERCONNECTION DETAILS

DRAWING NO.:

PV-102

DRAWN BY:

LR

REVIEWED BY:

DATE: 09/17/19

SCALE:

AS SHOWN

PROJECT NO.:

SCALE: NTS

4 REVENUE METER

SCALE: NTS

COMPANY NEUTRAL (WHERE FURNISHED)